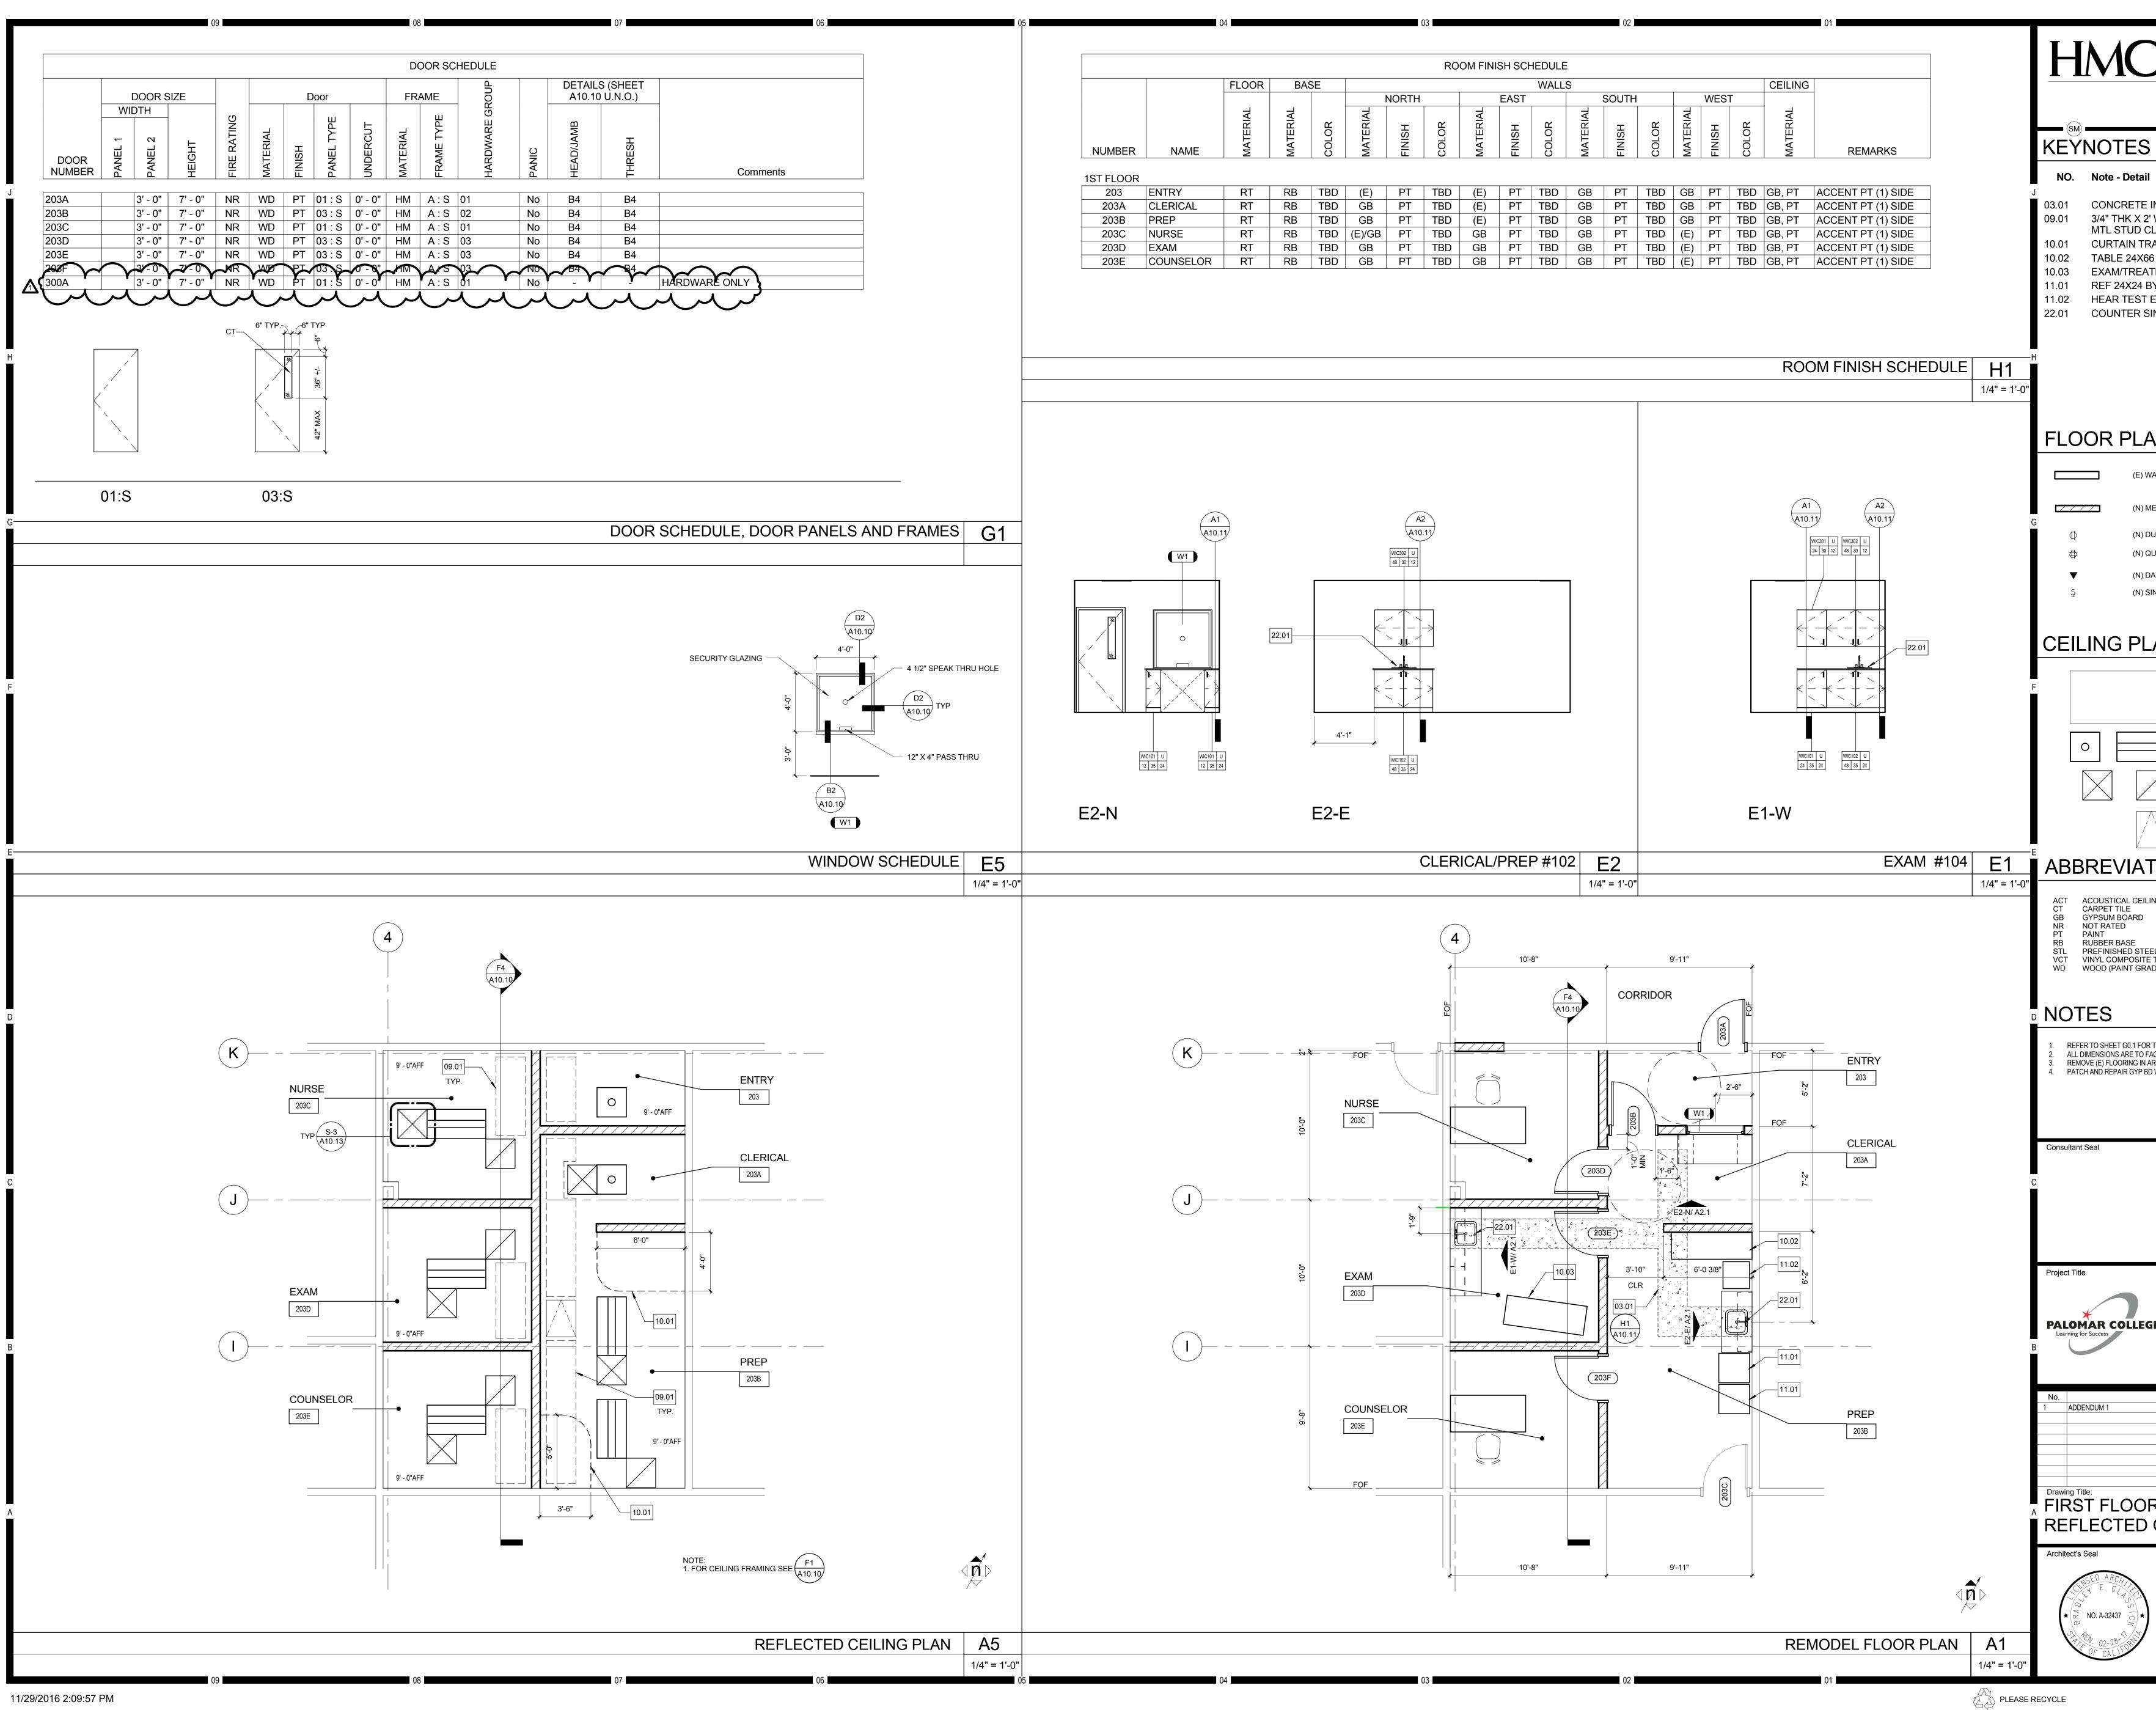


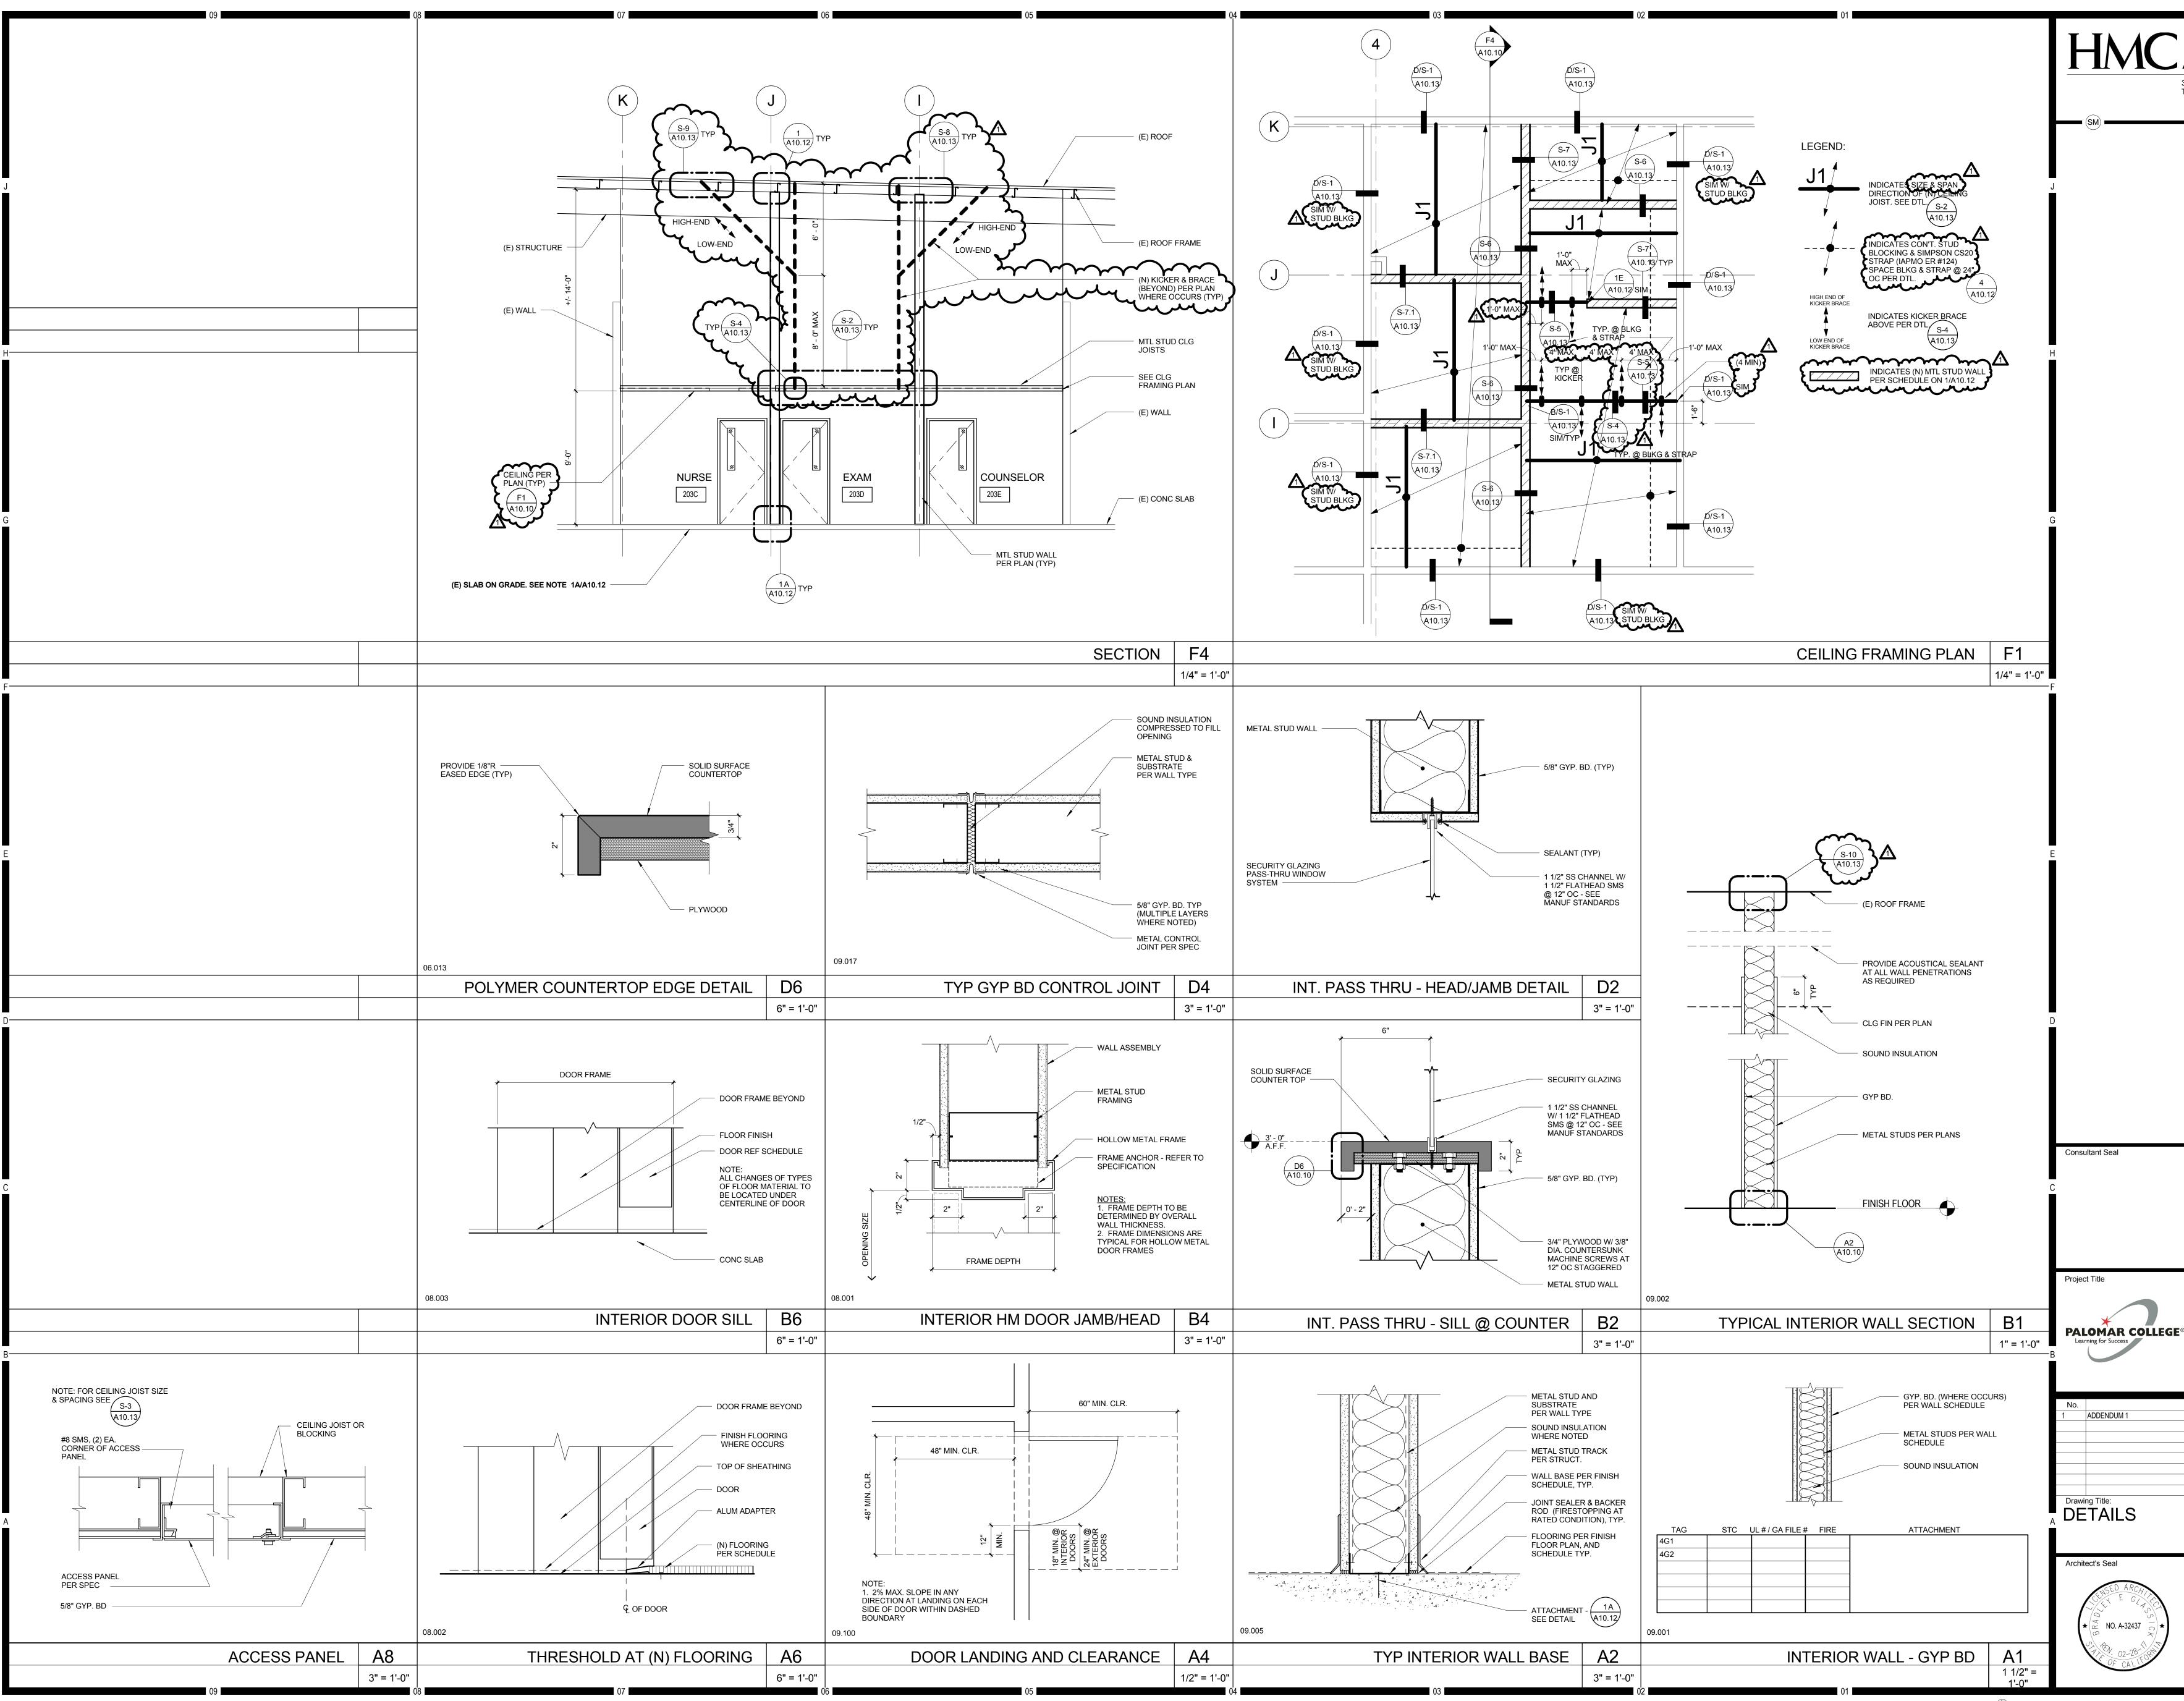
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Agency Approval FILE NO. PALOMAR COMMUNITY COLLEGE ESCONDIDO HEALTH CENTER TI PALOMAR COLLEGE 1951 EAST VALLEY PARKWAY ESCONDIDO, CA 92025 Date 11/30/2016 Description Designed. Designer 5015015 Scale: Drawr As indicated Author QAQC Drawing No. Checker A1.1 Date: 10/28/16

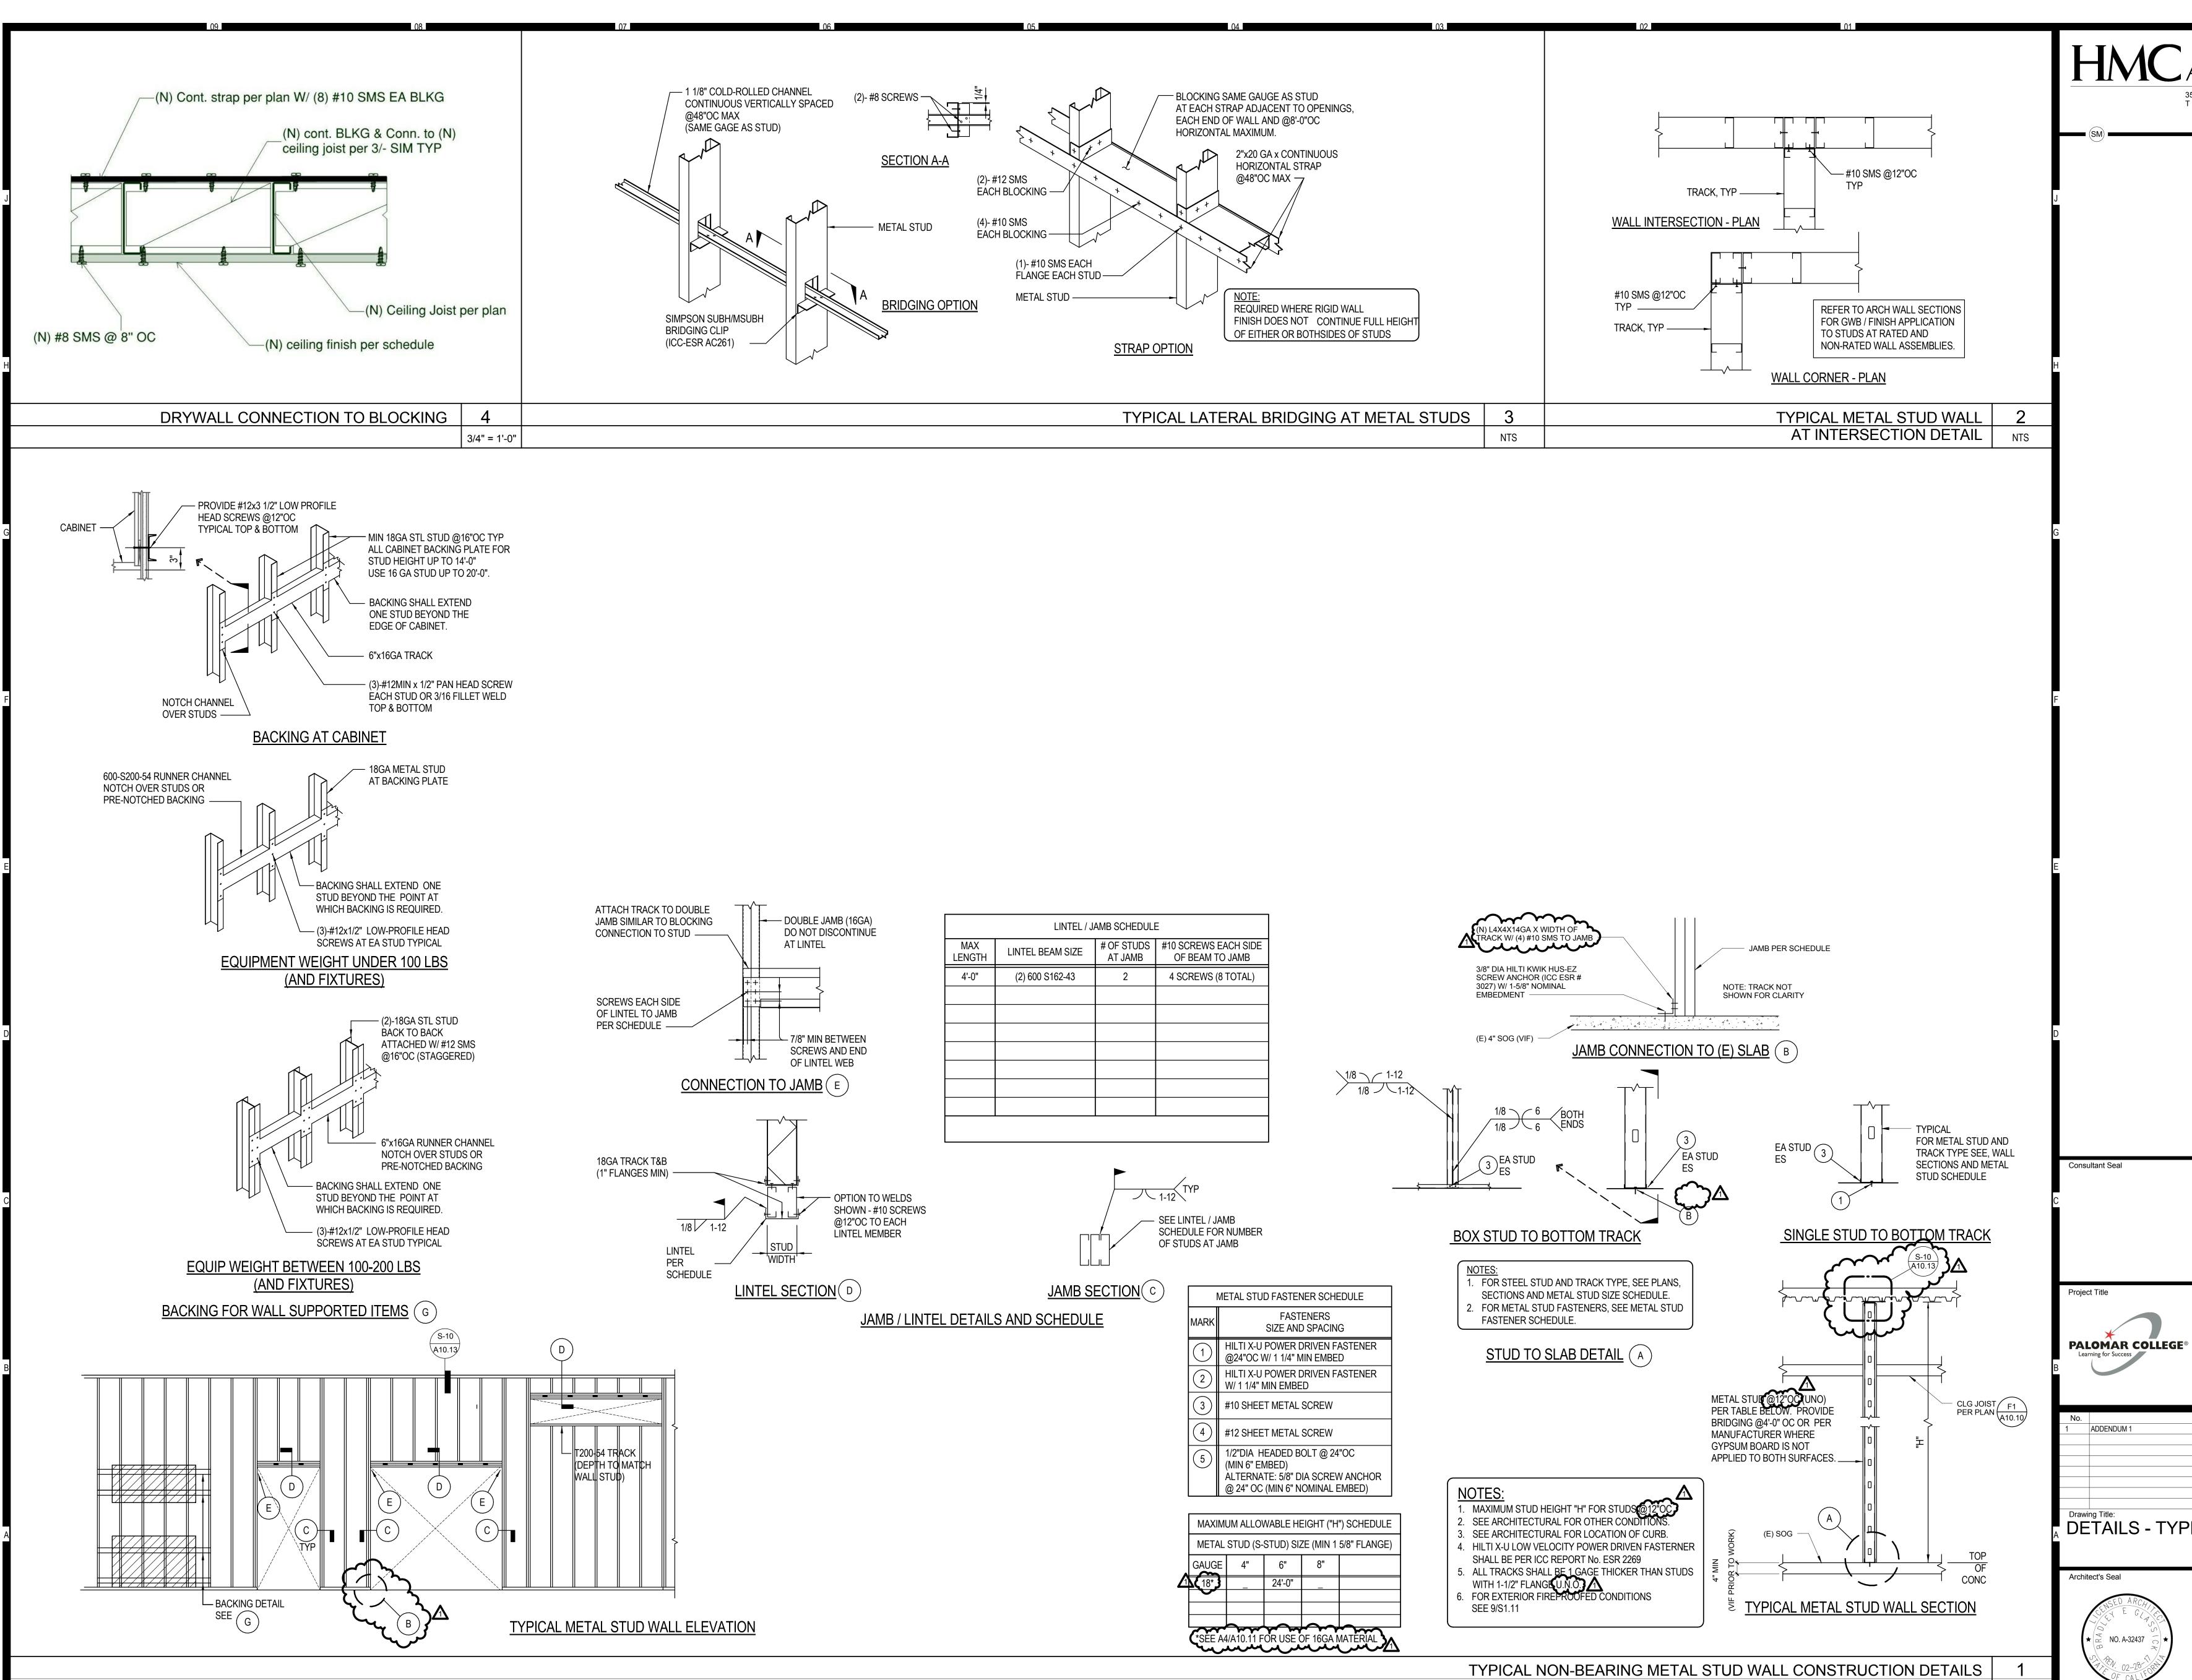


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CLG JO RACK 66 BY ATMEN BY OV	L E PLYWOOD WALKING SURFACE ON OISTS OWNER NT CHAIR BY OWNER
AN	LEGEND
METAL S DUPLEX QUAD C DATA O	
_AN	N LEGEND
	5/8" GYP. BD. CEILING ON MTL STUD JOISTS PER F1 A10.10 (N) LIGHT FIXTURE - REFER TO E1.2
	) (N) MECHANICAL REGISTERS - REFER TO M2.1
	(N) 24"X30" CEILING ACCESS PANEL (A8) (A10.10)
TIC	DNS E
EEL FRA E TILE ( ADE)	AME ANTI-STATIC)
FACE OF AREAS A	AL SYMBOLS AND ABBREVIATIONS. STUD U.N.O. IFFECTED BY NEW CONSTRUCTION. FINISH AT ABANDONED/DISCONNECTED ELECTRICAL BOXES.
	Agency Approval FILE NO.
GE®	PALOMAR COMMUNITY COLLEGE ESCONDIDO HEALTH CENTER TI PALOMAR COLLEGE 1951 EAST VALLEY PARKWAY ESCONDIDO, CA 92025
	Description Date 11/30/2016
	REMODEL PLAN & EILING PLAN
)	Designed: Designer       Project No.       5015015         Drawn:       Author       Scale: As indicated         QAQC       Drawing No.
	Date: 10/28/16



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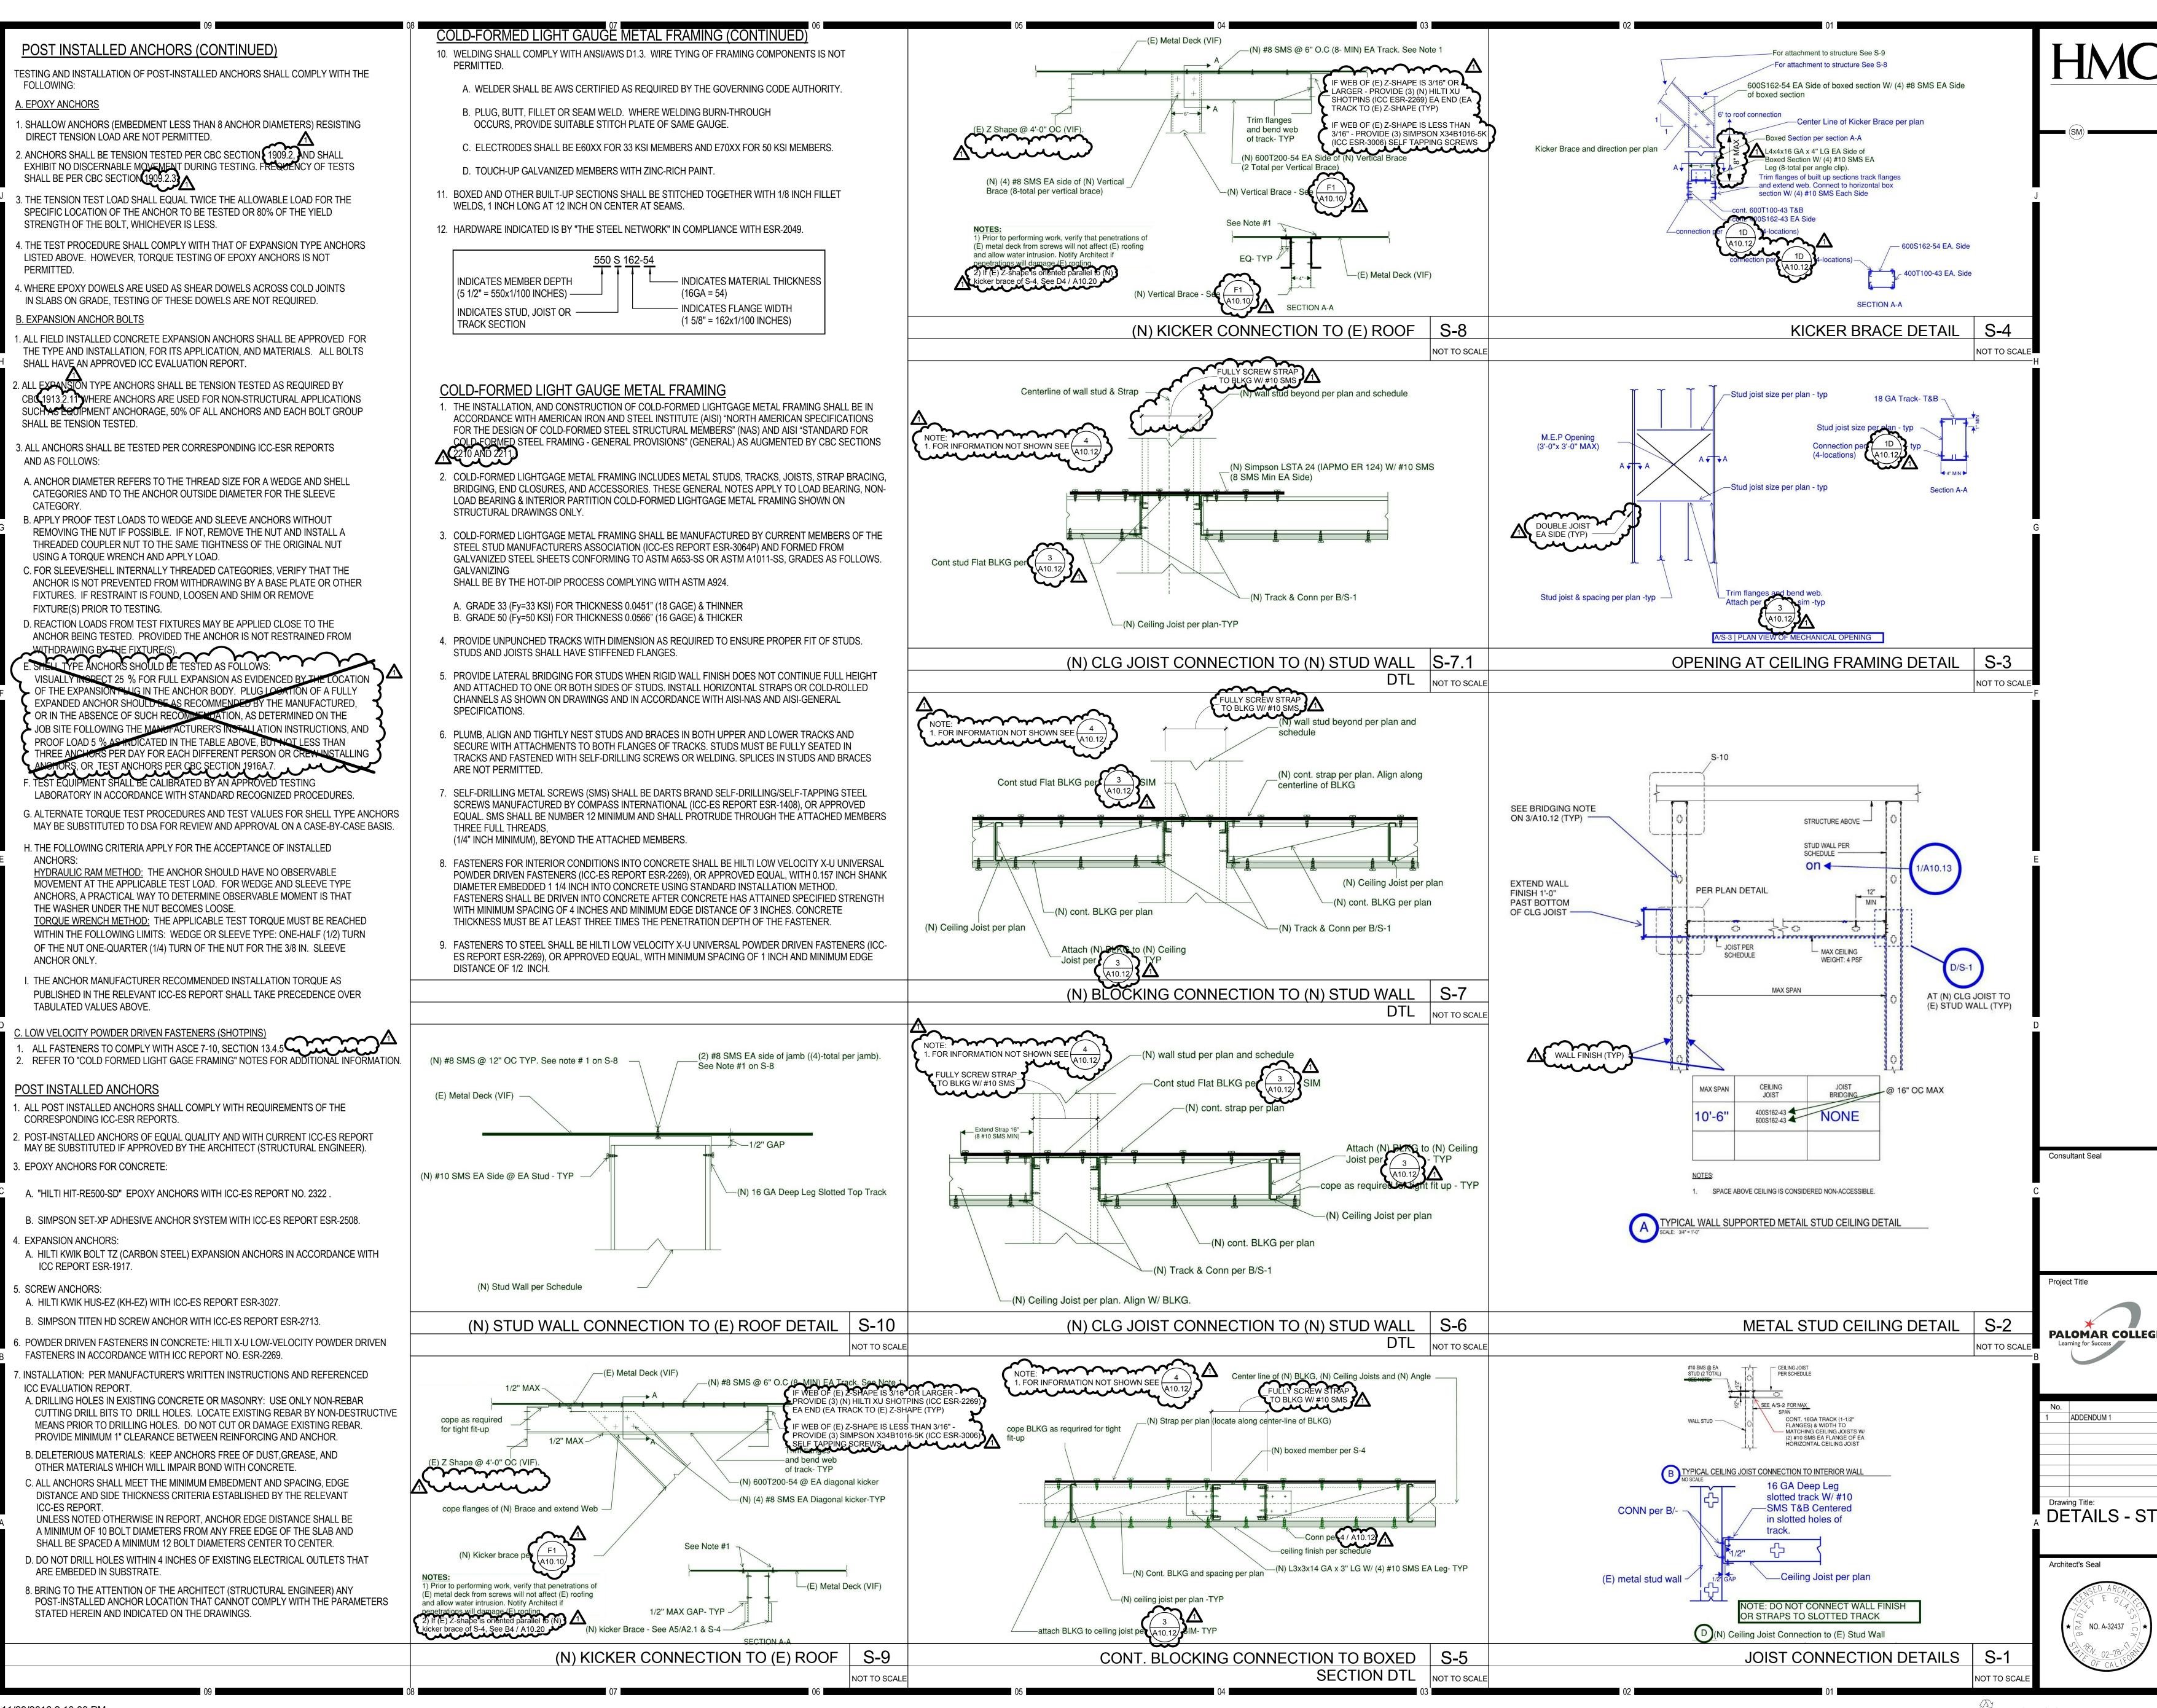
	Agency Approval	FILE NO.								
<b>GE</b> ®	PALOMAR COMMUNITY COLLEGE ESCONDIDO HEALTH CENTER TI									
	PALOM 1951 EAST \ ESCONE	RKWAY								
	Description		Date 11/30/2016							
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	Designed <sup>.</sup> Designer	Project No.	5015015							
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,	Date: 10/28/16	A1	0.10							



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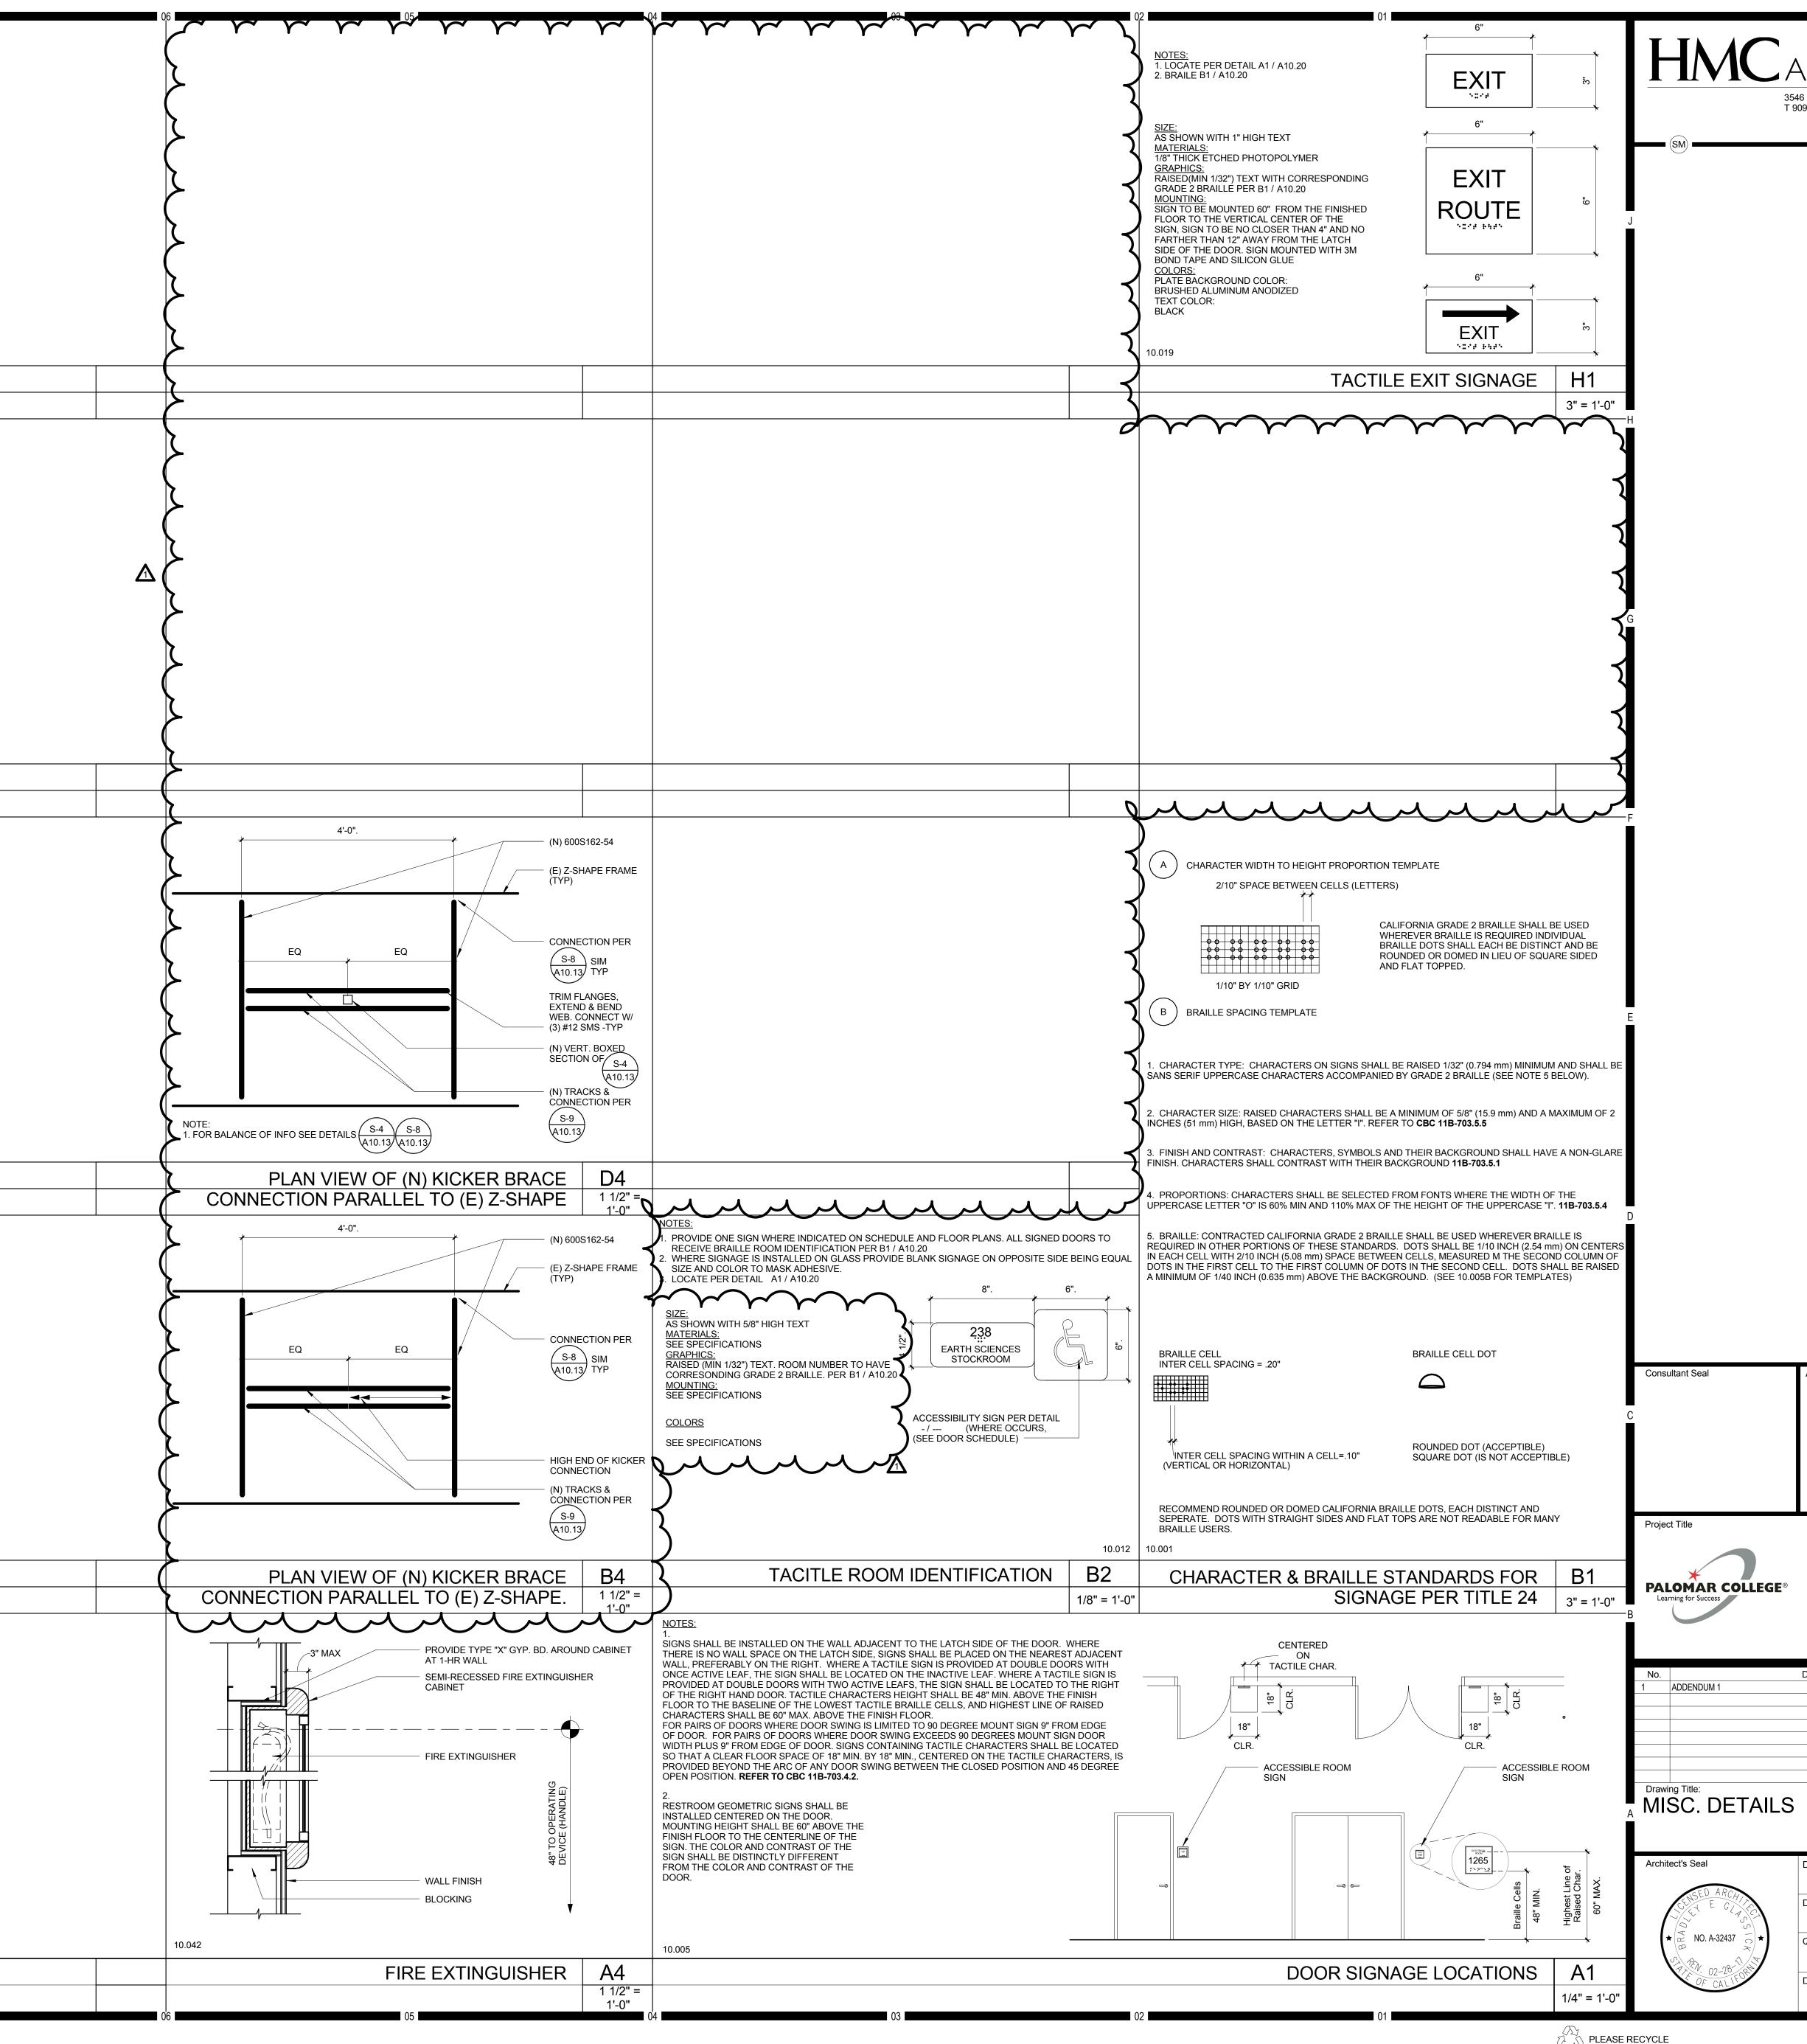
	Agency Approval	FILE NO.									
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<b>GE</b> ®	ESCONDIDO HEALTH CENTER TI										
~ ~	PALOMAR COLLEGE 1951 EAST VALLEY PARKWAY ESCONDIDO, CA 92025										
	Description	Date 11/30/2016									
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YPI	Designed: LR Drawn: JPR QAQC	Project No. Scale: Drawing No.	5015015								



Agency Approval FILE NO.	
GE® PALOMAR COMMUNITY COLLEGE ESCONDIDO HEALTH CENTER TI PALOMAR COLLEGE 1951 EAST VALLEY PARKWAY ESCONDIDO, CA 92025	
Description Date 11/30/2016	9
TRUCTURAL FRAMING	
Designed: Designer Drawn: Author Project No. 50150 Scale: As indicat	
Checker Checker Drawing No. Date: 10/28/16	3

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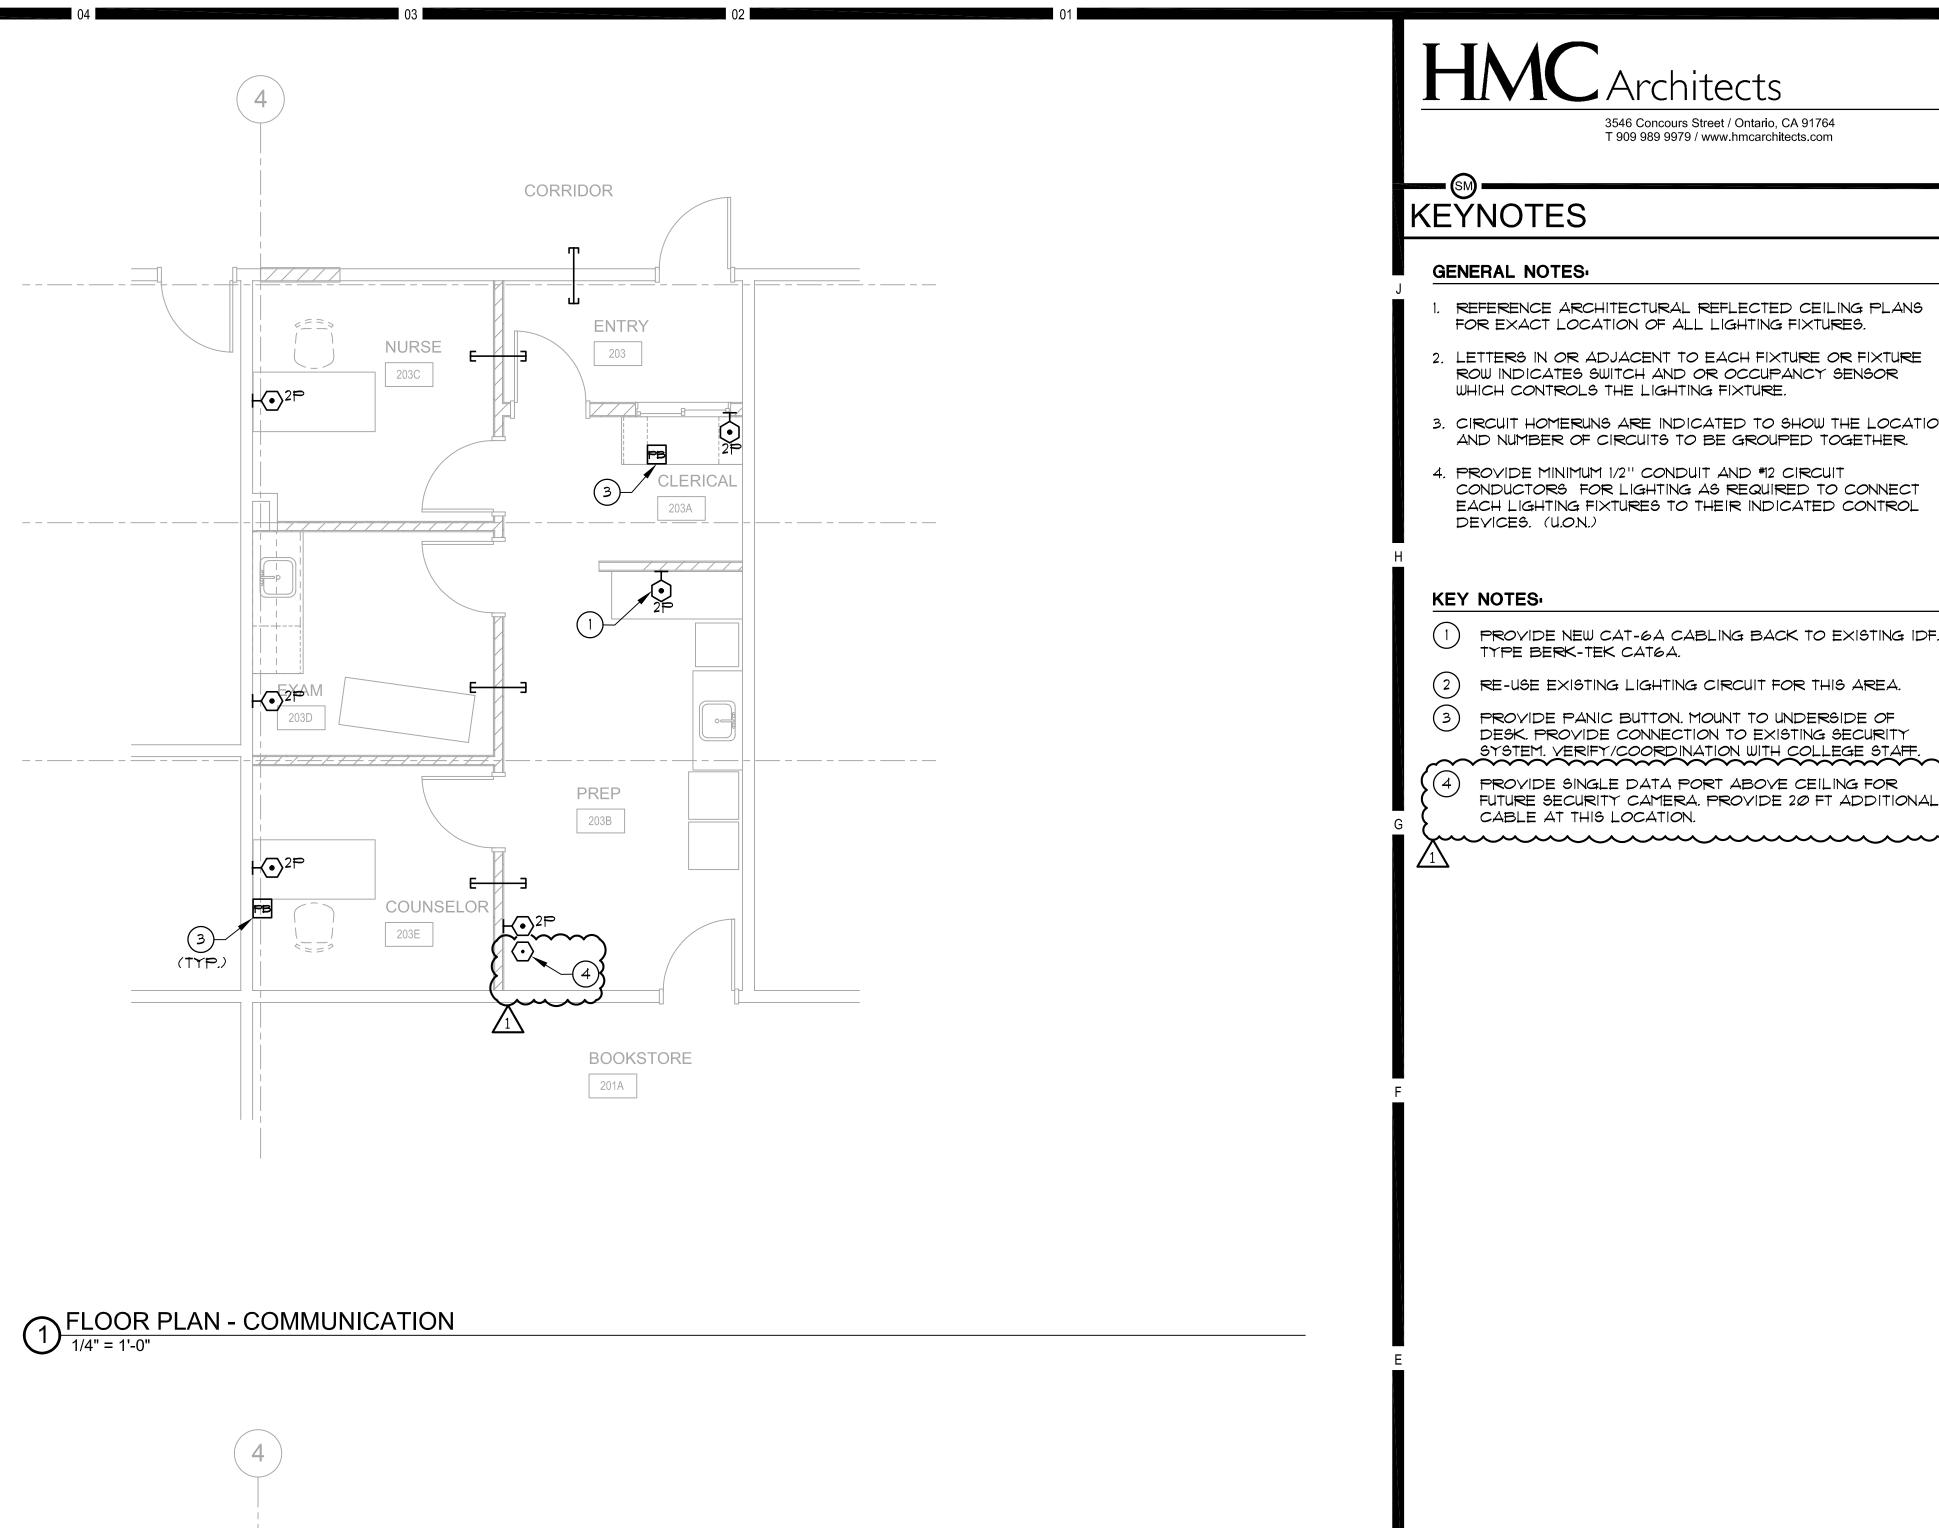
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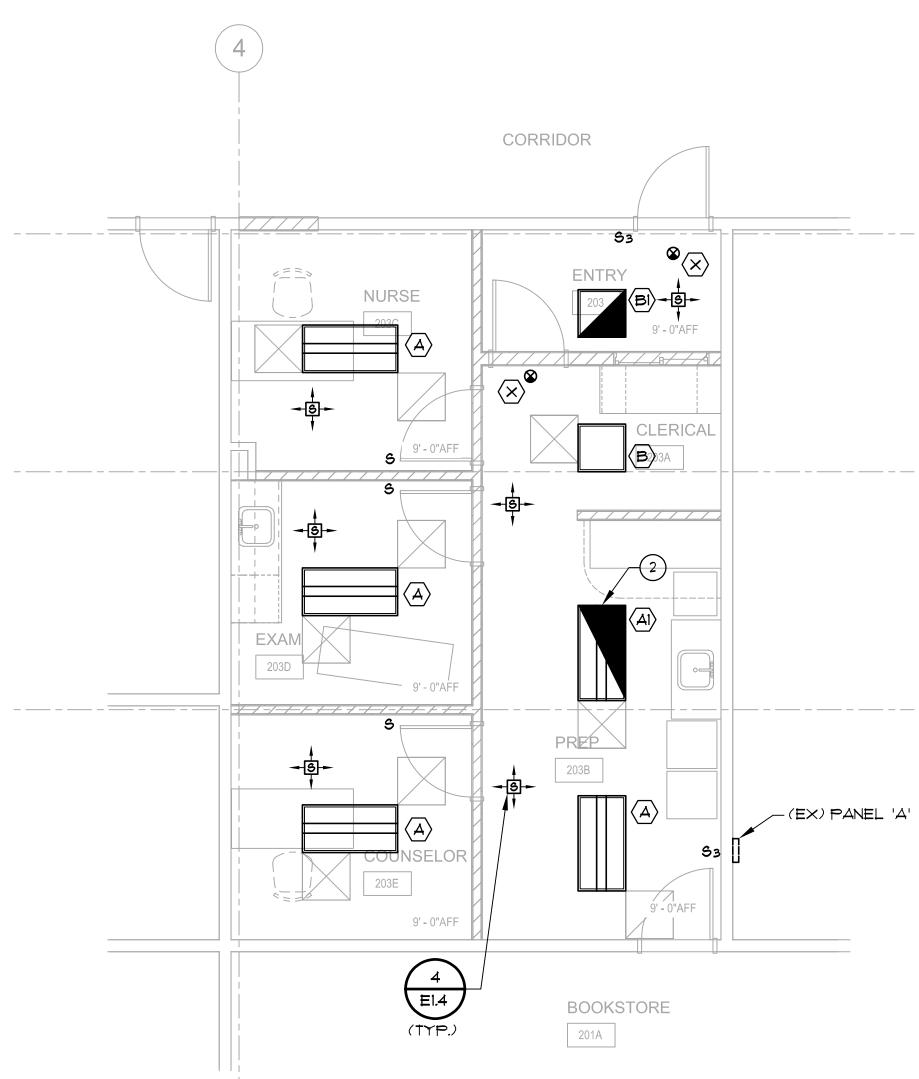
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GE®	PALOMAR CO ESCONDIDO I		
	PALOM 1951 EAST \ ESCONE	WAY	
	Description		Date 11/30/2016
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	Designed. Designer Drawn: Author	Project No. Scale:	5015015 As indicated
	QAQC Date: 10/28/16	Drawing No.	0.20



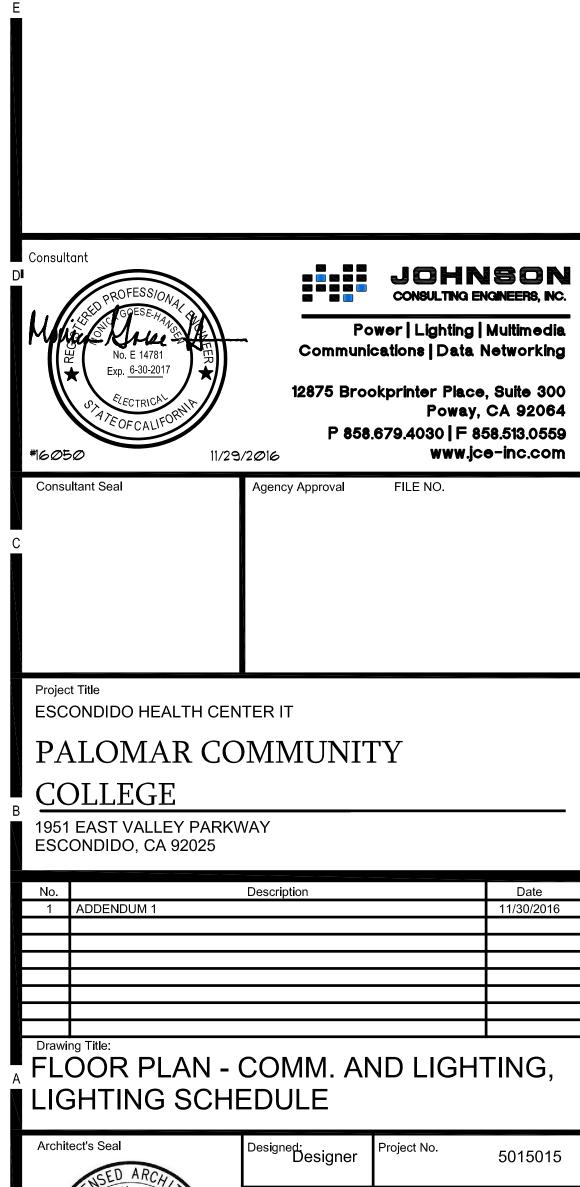
Mark	Approved Manufacturer's ( See Key Note No.1)	Catalog Seri ( See Key Note No.2)
	CREE	CR24 Serie
	LITHONIA LIGHTING	
$\langle \mathbf{A} \rangle$		
	0055	
	CREE	CR24 Serie
	LIGHTING	•
$\langle A1 \rangle$		
	CREE	CR24 Serie
	LITHONIA LIGHTING	
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<b>(B</b> )		
	CREE	CR24 Serie
	LITHONIA LIGHTING	•
$\langle B1 \rangle$		
	ISOLITE	SLX—60 Se
	Penteco	P160 Serie
$\langle \mathbf{x} \rangle$	SRB Tech.	171 Series
	Lightolier	TE Series
	Mule	EGX Series
x		



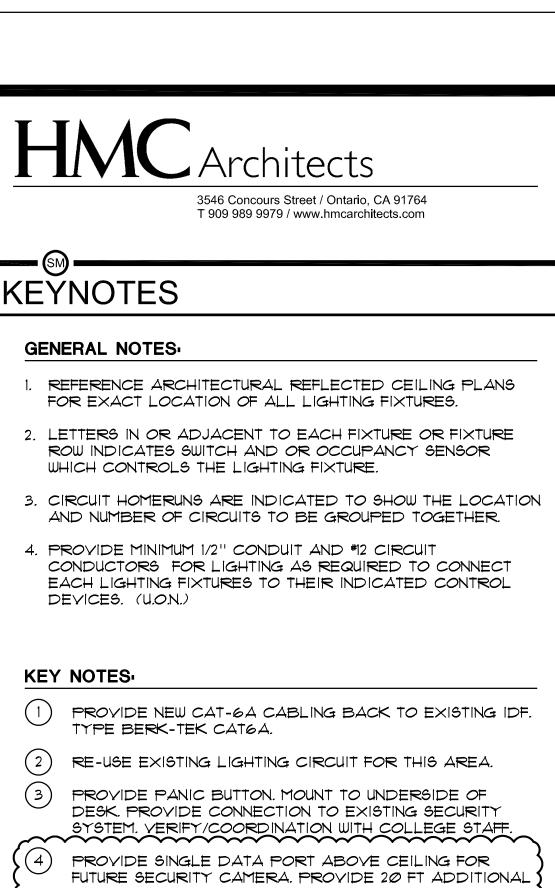
LIGHTING FIXTURE SCHEDULE																								
					FIX	TUR			LA	мр			MOU	INTIN	NG									
<sup>,</sup> Туре	Incandescent	Fluorescent	Metal Halide	High pressuresodium	Low pressuresodium	LED	Volts	Lamp Watts Fixture Watts	NO.	Туре		Surface/ Ceiling wall	/ 1000	Recessed / Wall	ŀ	Surface / Wall	Pole				Descri	ption		
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2 FLOOR PLAN - LIGHTING



★ (× NO. C-19082 <sup>™</sup>) ★



Scale: Drawn: As indicated Author QAQC Drawing No. Checker E1.2 Date: 06/28/16